
NEW PROPOSED BAY SHORE PUBLIC LIBRARY

LOCATION: 2 GARNER LANE, BAY SHORE NY

THE GOAL OF THIS PROJECT IS TO DESIGN A MODERN, INNOVATIVE, SITE-SPECIFIC PROJECT FEATURING A CLEAR CONCEPT, A GREEN ROOF WITH A SPECIFIED FUNCTION, AND INCORPORATING A MINIMUM OF THREE OTHER SUSTAINABLE BUILDING OR SITE FEATURES. THE PUBLIC LIBRARY WILL INCLUDE AN AREA FOR CHILDREN, TEENS AND ADULTS. AS WELL AS A COMMUNITY ROOM THAT WILL BE ABLE TO SEAT 150 PEOPLE. A 2,500-SQUARE-FOOT CAFE WITH A DRIVE-THRU WILL BE LOCATED ON THE SITE

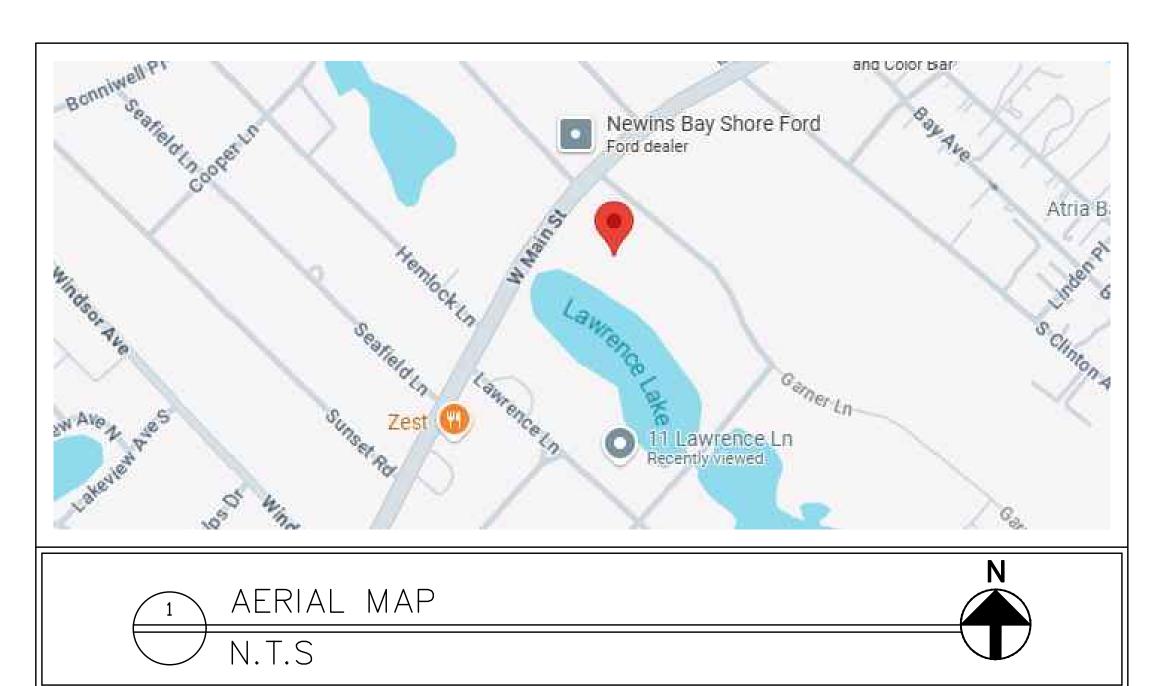



LOCATION MAP



ABBREVIATIONS

ADJ. ADJACENT REF. REFERENCE REINF. REINFORCED BM. BEAM CONC. CONCRETE REQ'D. REQUIRED CEM. CEMENT R.D. ROOF DRAIN C.L. CENTER LINE RM. ROOM CL. CLOSET SECT. SECTION CLG. CEILING S.F. SQUARE FEET COL. COLUMN SHTG. SHEATHING CONT. CONTINUOUS SQ. SQUARE DIM. DIMENSION STL. STEEL STRUCT. STRUCTURE EXIST. EXISTING EXT. EXTERIOR THRESH. THRESHOLD FDN. FOUNDATION TYP. TYPICAL FT. FOOT OR FEET SAN. SANITARY TOB. TOP OF BEAM H. HEIGHT TOC. TOP OF CURB OR TOP OF CONCRETE IN. INCHES INCL. INCLUDE TOF. TOP OF FOOTING INSUL. INSULATION TOJ. TOP OF JOIST INT. INTERIOR TOM. TOP OF MASONRY L. LENGTH TOW. TOP OF WALL MIN. MINIMUM VERT. VERTICAL N.T.S NOT TO SCALE W. WIDE

SITE INFORMATION

WD. WOOD

W.P WATERPROOF

ZONING: BUSINESS DISTRICT 1

O.C. ON CENTER

PLYWD. PLYWOOD

PERMITTED USE: LIBRARY

LOT AREA: 4.8 ACRE (209,088 S.F)

LOT AREA UNDER WATER: 1.07 ACRE (46.741 S.F)

ADJUSTED LOT AREA: 3.73 ACRE (209.088 S.F)

TOTAL ALLOWABLE BUILDING AREA: 83,635.25 S.F

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L 101 LANDSCAPE PLAN

A 101 CONSTRUCTION DETAILS

PROJECT NAME

PROPOSED BAY SHORE LIBRARY

NOT FOR CONSTRUCTION

VER SHEET

ARCHITECTURAL DESIGN

COLLEGE

INGDALE

FARM

ASS

	REVISIONS
REV.	DATE

DRAWN: CHRISTOPHER VIZCARRA
DATE: 08/03/2025

SCALE:

CHECKED: P. LOPICCOLO

G 001

GENERAL NOTES:

THE FOLLOWING NOTES SHALL APPLY THROUGHOUT.

EXCEPTIONS ARE SPECIFICALLY NOTED ON EACH DRAWING

- PROJECT OVERVIEW:THIS PROJECT IS UNDER PRELIMINARY REVIEW AND HAS BEEN MARKED "NOT FOR CONSTRUCTION." ALL DESIGNS, DIMENSIONS, AND SPECIFICATIONS SHOWN ON THESE DOCUMENTS ARE SUBJECT TO FURTHER REVISION AND APPROVAL.
- 2. ZONING AND LAND USE COMPLIANCE: THE PROJECT WILL ADHERE TO THE TOWN OF HEMPSTEAD BUILDING ZONE ORDINANCE. ALL PROPOSED USES, SITE IMPROVEMENTS, AND BUILDING MODIFICATIONS WILL BE EVALUATED FOR COMPLIANCE WITH LOCAL ZONING REGULATIONS. ANY NECESSARY VARIANCES OR SPECIAL USE PERMITS WILL BE OBTAINED PRIOR TO FINAL APPROVAL.
- 3. ENVIRONMENTAL COMPLIANCE: COMPLIANCE WITH THE NEW YORK STATE ENVIRONMENTAL QUALITY REVIEW ACT (SEQRA) WILL BE ENSURED. A DETERMINATION OF SIGNIFICANCE WILL BE MADE TO ASSESS POTENTIAL ENVIRONMENTAL IMPACTS, AND APPROPRIATE MEASURES WILL BE TAKEN TO MITIGATE ANY IDENTIFIED ISSUES.
- 4. ROAD CLASSIFICATION AND VERIFICATION:BABYLON TURNPIKE IS VERIFIED AS A COUNTY ROAD, AND ALL SITE PLANS AND TRAFFIC IMPACT STUDIES WILL REFLECT THIS DESIGNATION. COORDINATION WITH NASSAU COUNTY DEPARTMENT OF PUBLIC WORKS WILL BE NECESSARY FOR ANY PROPOSED CURB CUTS, DRAINAGE, OR ROADWAY IMPROVEMENTS.
- 5. SANITARY, MECHANICAL, AND FACILITY REQUIREMENTS: THE BUILDING WILL INCLUDE PROVISIONS FOR SANITARY FACILITIES, A COMMERCIAL KITCHEN, AND A MECHANICAL ROOM IN COMPLIANCE WITH APPLICABLE TOWN OF HEMPSTEAD AND NASSAU COUNTY BUILDING CODES. SPECIFIC REQUIREMENTS FOR WATER SUPPLY, DRAINAGE, AND HVAC SYSTEMS WILL BE FINALIZED IN THE CONSTRUCTION PHASE.
- 6. PARKING AND SITE ACCESSIBILITY: NO ON-SITE PARKING IS PROVIDED. A COMPREHENSIVE STUDY OF THE SITE'S ACCESSIBILITY, INCLUDING ALTERNATIVE PARKING SOLUTIONS, WILL BE COMPLETED TO ENSURE COMPLIANCE WITH BOTH THE AMERICANS WITH DISABILITIES ACT (ADA) AND LOCAL PLANNING REGULATIONS.
- FLOODPLAIN AND DRAINAGE: A REVIEW OF THE SITE'S LOCATION RELATIVE 16.
 TO FLOOD ZONES AS DEFINED BY THE FEMA FLOOD INSURANCE RATE MAPS
 (FIRM) WILL BE CONDUCTED. ADEQUATE DRAINAGE PLANS MUST BE 17.
 INCORPORATED TO MANAGE STORMWATER RUNOFF IN ACCORDANCE WITH LOCAL AND STATE GUIDELINES.
- 8. UTILITY COORDINATION: ALL UTILITY CONNECTIONS, INCLUDING WATER, SEWER, GAS, AND ELECTRICITY, WILL BE COORDINATED WITH THE RELEVANT SERVICE PROVIDERS. PLANS FOR UTILITY ROUTING MUST COMPLY WITH LOCAL AND COUNTY REQUIREMENTS.

- 9. UTILITY COORDINATION: ALL UTILITY CONNECTIONS, INCLUDING WATER, SEWER, GAS, AND ELECTRICITY, WILL BE COORDINATED WITH THE RELEVANT SERVICE PROVIDERS. PLANS FOR UTILITY ROUTING MUST COMPLY WITH LOCAL AND COUNTY REQUIREMENTS.
- 10. LIMITATIONS OF CURRENT DOCUMENTATION: THIS SET OF DOCUMENTS IS
 FOR PRELIMINARY REVIEW ONLY AND IS SUBJECT TO FURTHER
 MODIFICATIONS. ALL DETAILS PROVIDED HEREIN MUST BE VERIFIED BY THE
 CONTRACTOR, DESIGN TEAM, AND RELEVANT MUNICIPAL AUTHORITIES
 BEFORE ANY CONSTRUCTION COMMENCES.
- 11. CHAPTER 11, NEW YORK STATE BUILDING CODE COMPLIANCE: THE PROJECT WILL ADHERE TO THE ACCESSIBILITY REQUIREMENTS OF CHAPTER 11 OF THE NEW YORK STATE BUILDING CODE, WHICH GOVERNS ACCESSIBILITY TO BUILDINGS FOR PEOPLE WITH DISABILITIES. SPECIFIC ATTENTION WILL BE GIVEN TO COMPLIANCE WITH ICC/ANSI A117.1 (2017), WHICH SETS STANDARDS FOR ACCESSIBLE AND USABLE BUILDINGS AND FACILITIES.
- ACCESSIBLE ROUTES: ALL PEDESTRIAN ROUTES, INCLUDING BUILDING ENTRANCES, PATHS, AND CORRIDORS, WILL COMPLY WITH THE SLOPE, WIDTH, AND SURFACE STANDARDS REQUIRED BY CHAPTER 11 AND ANSI 117.1.
- 13. ENTRANCES AND EXITS: ENTRANCES AND EXITS WILL BE DESIGNED TO ENSURE COMPLIANCE WITH ACCESSIBILITY STANDARDS, INCLUDING CLEAR WIDTH, MANEUVERING SPACE, AND THRESHOLDS IN ACCORDANCE WITH ANSI A117.1.
- 14. RESTROOMS AND FACILITIES: ALL SANITARY FACILITIES WILL MEET ACCESSIBILITY REQUIREMENTS, WITH ADEQUATE MANEUVERING SPACE, GRAB BARS, AND APPROPRIATE FIXTURE HEIGHTS AS SPECIFIED IN ANSI A117.1 (2017).
- 15. PARKING AND ACCESSIBLE SPACES: IF PARKING IS TO BE INCORPORATED,
 THE REQUIRED NUMBER OF ACCESSIBLE PARKING SPACES WILL BE
 PROVIDED IN ACCORDANCE WITH CHAPTER 11 AND ANSI STANDARDS,
 INCLUDING APPROPRIATE SIGNAGE AND PATH ACCESS.
- 6. OCCUPANT LOAD: CALCULATION OF MAXIMUM OCCUPANT LOAD FOR THE BANQUET HALL AND OTHER ASSEMBLY SPACES.
- 17. FIRE PROTECTION SYSTEMS: REQUIREMENTS FOR AUTOMATIC SPRINKLER SYSTEMS, FIRE ALARMS, AND KITCHEN HOOD SUPPRESSION SYSTEMS WHERE COOKING EQUIPMENT IS PRESENT.
- 18. EGRESS REQUIREMENTS: ENSURING SUFFICIENT AND ACCESSIBLE EMERGENCY EXITS, EXIT SIGNAGE, AND CLEAR PATHS OF EGRESS IN COMPLIANCE WITH FIRE SAFETY STANDARDS.

ZONING INFORMATION				
ZONING SECTION	ITEM	REQUIRED	PROPOSED	
68-280	FRONT YARD	10'	57'	
68-281	SIDE YARD	10'	10'	
68-282	REAR YARD	10'	25'	
68-284	RESIDENTIAL BUFFER	25'	25'	
68-281	SIDE SETBACK	10'	10'	
68-276	FLOOR AREA RATIO	0.40	X	
68-276	BUILDING HEIGHT	35'	35'	

BUILDING AREA SUMMARY

PARKING

FLOOR	AREA
FIRST	26,955 S.F
SECOND	16,540 S.F
ROOF	43,495 S.F

120

SITE INFORMATION

ZONING: BUSINESS DISTRICT 1

PERMITTED USE: LIBRARY

LOT AREA: 4.8 ACRE (209,088 S.F)

LOT AREA UNDER WATER: 1.07 ACRE (46.741 S.F)

ADJUSTED LOT AREA: 3.73 ACRE (209.088 S.F)

TOTAL ALLOWABLE BUILDING AREA: 83,635.25 S.F

PROJECT NAME	
PROPOSED BAY SHORE LIBRARY	

NOT FOR CONSTRUCTION

GENERAL NOTES

120

ARCHITECTURAL DESIGN

COLLE

STATE

INGDALE

FARM

REVISIONS

REV. DATE

DRAWN: CHRISTOPHER VIZCARRA
DATE: 08/03/2025
SCALE:
CHECKED: P. LOPICCOLO

G 002



LEGEND				
DESCRIPTION	SYMBOL			
EXISTING BLDG.				
REMOVED STRUCT.				
EXISTING TREE				
REMOVED TREE				
PROPERTY LINE				

SITE INFORMATION

ZONING: BUSINESS DISTRICT 1

PERMITTED USE: LIBRARY

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DEMO NOTES

1. THE OWNER RESERVES THE RIGHT TO REVIEW ALL MATERIALS DESIGNATED FOR REMOVAL AND TO RETAIN OWNERSHIP OF SUCH MATERIALS.

IF THE OWNER RETAINS ANY MATERIAL THE CONTRACTOR SHALL MAKE ARRANGEMENTS WITH THE OWNER TO HAVE THOSE MATERIALS REMOVED OFF SITE AT NO ADDITIONAL COST.

2. UNLESS SPECIFICALLY NOTED TO BE SAVED / STOCKPILED (R&S) OR REUSED / RELOCATED (R&R), ALL SITE FEATURES CALLED FOR REMOVAL (REM) SHALL BE REMOVED WITH THEIR FOOTINGS, ATTACHMENTS, BASE MATERIAL, ETC, TRANSPORTED FROM THE SITE TO BE DISPOSED OF IN A LAWFUL MANNER AT AN ACCEPTABLE DISPOSAL SITE AND AT NO COST TO THE OWNER

3. ALL EXISTING SITE FEATURES TO REMAIN SHALL BE PROTECTED THROUGHOUT THE CONSTRUCTION PERIOD. ANY FEATURES DAMAGED DURING CONSTRUCTION OPERATIONS SHALL BE REPAIRED OR REPLACED TO THE SATISFACTION OF THE OWNER'S REPRESENTATIVE AT NO

4. DURING EARTHWORK OPERATIONS, CONTRACTOR SHALL TAKE CARE TO NOT DISTURB EXISTING MATERIALS TO REMAIN, OUTSIDE THE LIMITS OF EXCAVATION AND BACKFILL AND SHALL TAKE WHATEVER MEASURES NECESSARY, AT THE CONTRACTOR'S EXPENSE, TO PREVENT ANY EXCAVATED MATERIAL FROM COLLAPSING. ALL BACKFILL MATERIALS SHALL BE PLACED AND COMPACTED AS SPECIFIED TO THE SUBGRADE REQUIRED FOR THE INSTALLATION OF THE REMAINDER OF THE CONTRACT WORK.

5. IT SHALL BE THE CONTRACTOR'S OPTION, WITH CONCURRENCE OF THE OWNER, TO REUSE EXISTING GRAVEL IF IT MEETS THE REQUIREMENTS OF THE SPECIFICATIONS FOR GRAVEL BORROW.

6. ALL ITEMS CALLED FOR REMOVAL SHALL BE REMOVED TO FULL DEPTH INCLUDING

ALL FOOTINGS, FOUNDATIONS, AND OTHER
APPURTENANCES, EXCEPT AS SPECIFICALLY NOTED OTHERWISE.
7. 'CLEAR AND GRUB VEGETATION' SHALL INCLUDE REMOVAL OF GRASS, SHRUBS,
AND UNDERBRUSH, REMOVAL OF ROOTS, ROUGH GRADING,
INSTALLATION OF LOAM (IF APPLICABLE), FINE GRADING, SEEDING AND TURF
ESTABLISHMENT BY THE CONTRACTOR.
8. TREES DESIGNATED FOR REMOVAL SHALL BE TAGGED BY CONTRACTOR AND
APPROVED BY OWNER'S REPRESENTATIVE PRIOR TO

COMMENCEMENT OF CONSTRUCTION.

9. THE STORAGE OF MATERIALS AND EQUIPMENT WILL BE PERMITTED AT LOCATIONS DESIGNATED BY OWNER OR OWNER'S REPRESENTATIVE.

PROTECTION OF STORED MATERIALS AND EQUIPMENT SHALL BE THE SOLE RESPONSIBILITY OF THE CONTRACTOR.

10. STRIP & STORE EXISTING TOPSOIL FOR LATER REUSE WHERE APPROPRIATE, AND AS NOTED ON PLAN, WITH APPROPRIATE EROSION AND

11. LOAM / TOP SOIL DESIGNATED FOR REUSE AS GENERAL FILL SHALL BE BLENDED WITH SUITABLE BORROW MATERIAL AS SPECIFIED.

12. THE CONTRACTOR SHALL PROTECT EXISTING TREES TO REMAIN, CONTRACTOR SHALL INSTALL TREE PROTECTION BARRIER AFTER CLEARING UNDERBRUSH AND TAKE DUE CARE TO PREVENT INJURY TO TREES DURING CLEARING OPERATIONS.

PROJECT NAME

PROPOSED BAY SHORE LIBRARY

NOT FOR CONSTRUCTION

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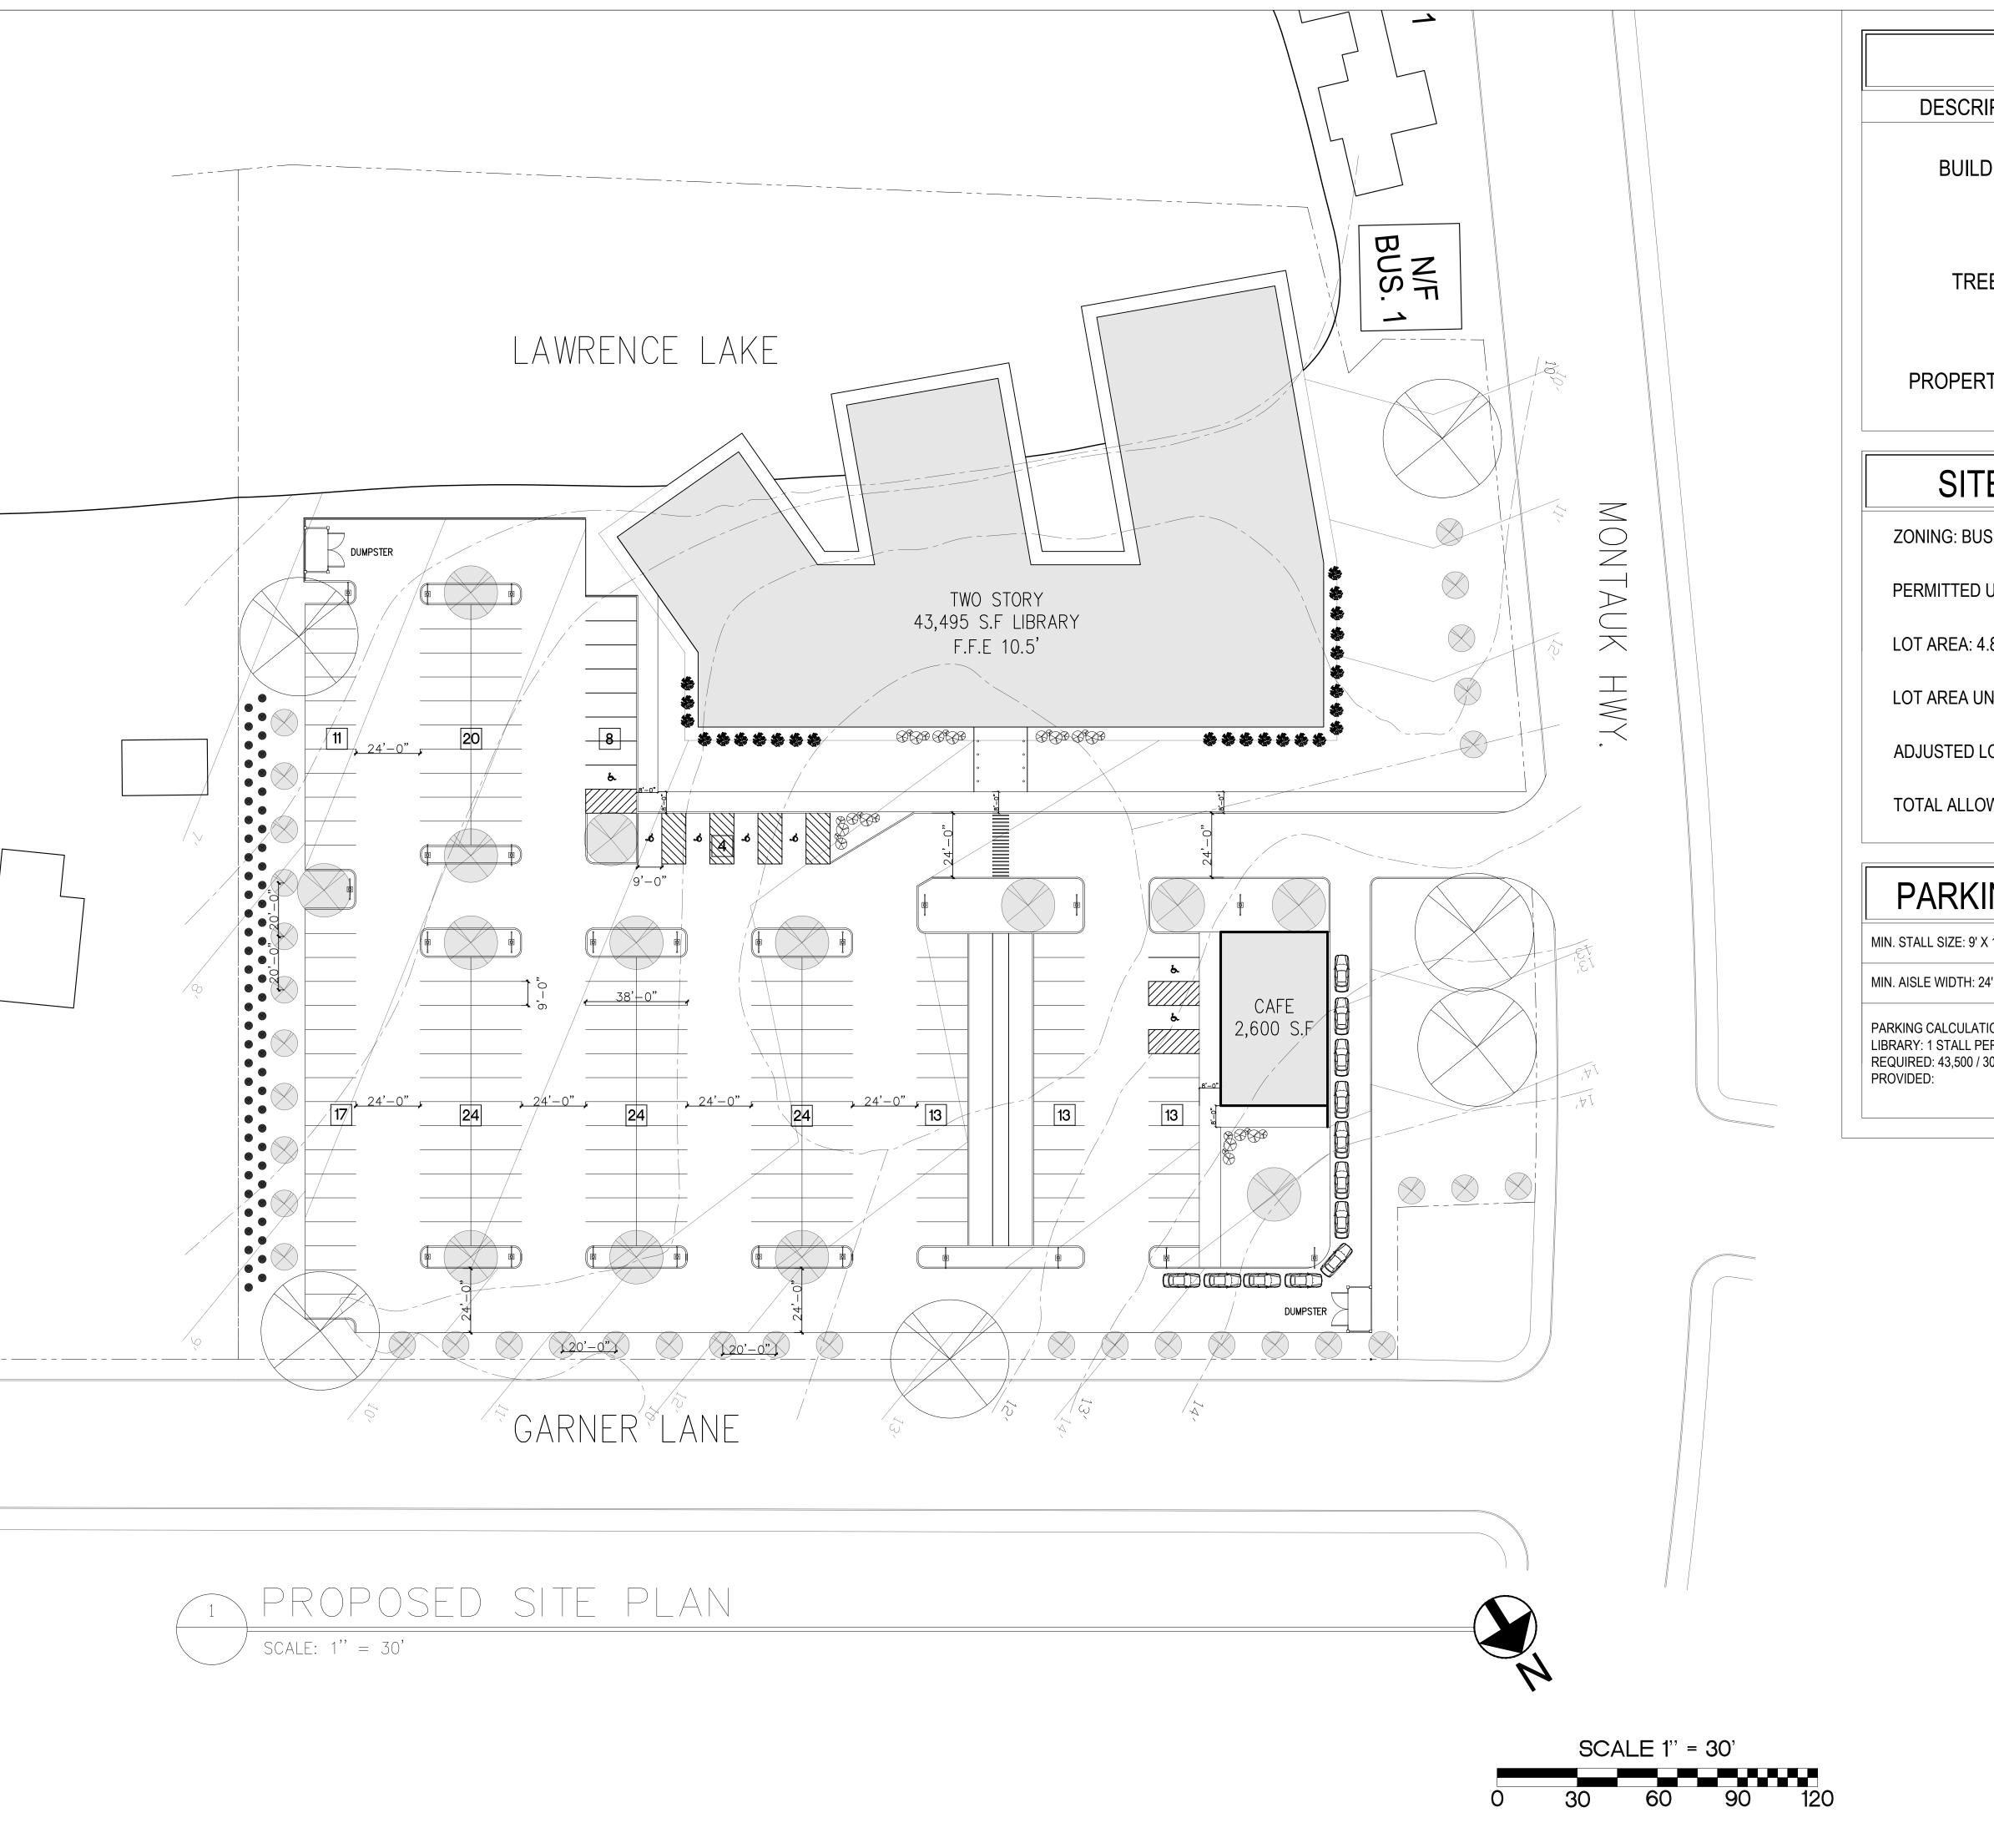
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DATE: 08/03/2025

SCALE: 1" = 30'

CHECKED: P. LOPICCOLO

G 003



LEGEND DESCRIPTION SYMBOL BUILDING **TREES** PROPERTY LINE

SITE INFORMATION

MIN. AISLE WIDTH: 24' REQUIRED

INCLUDING 5 ADA STALLS

PARKING CALCULATIONS: LIBRARY: 1 STALL PER 300 SF OF GFA PROJECT NAME

PROPOSED BAY SHORE LIBRARY

NOT FOR CONSTRUCTION

COLLEGE

STATE

INGDALE

FARM

DESIGN V

IITECTURAL

ARCH

ZONING: BUSINESS DISTRICT 1

PERMITTED USE: LIBRARY

LOT AREA: 4.8 ACRE (209,088 S.F)

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ADJUSTED LOT AREA: 3.73 ACRE (209.088 S.F)

TOTAL ALLOWABLE BUILDING AREA: 83,635.25 S.F

PARKING REQUIRMENTS

MIN. STALL SIZE: 9' X 19' REQUIRED

9' X 19' PROPOSED

24' PROPOSED

=145 STALLS

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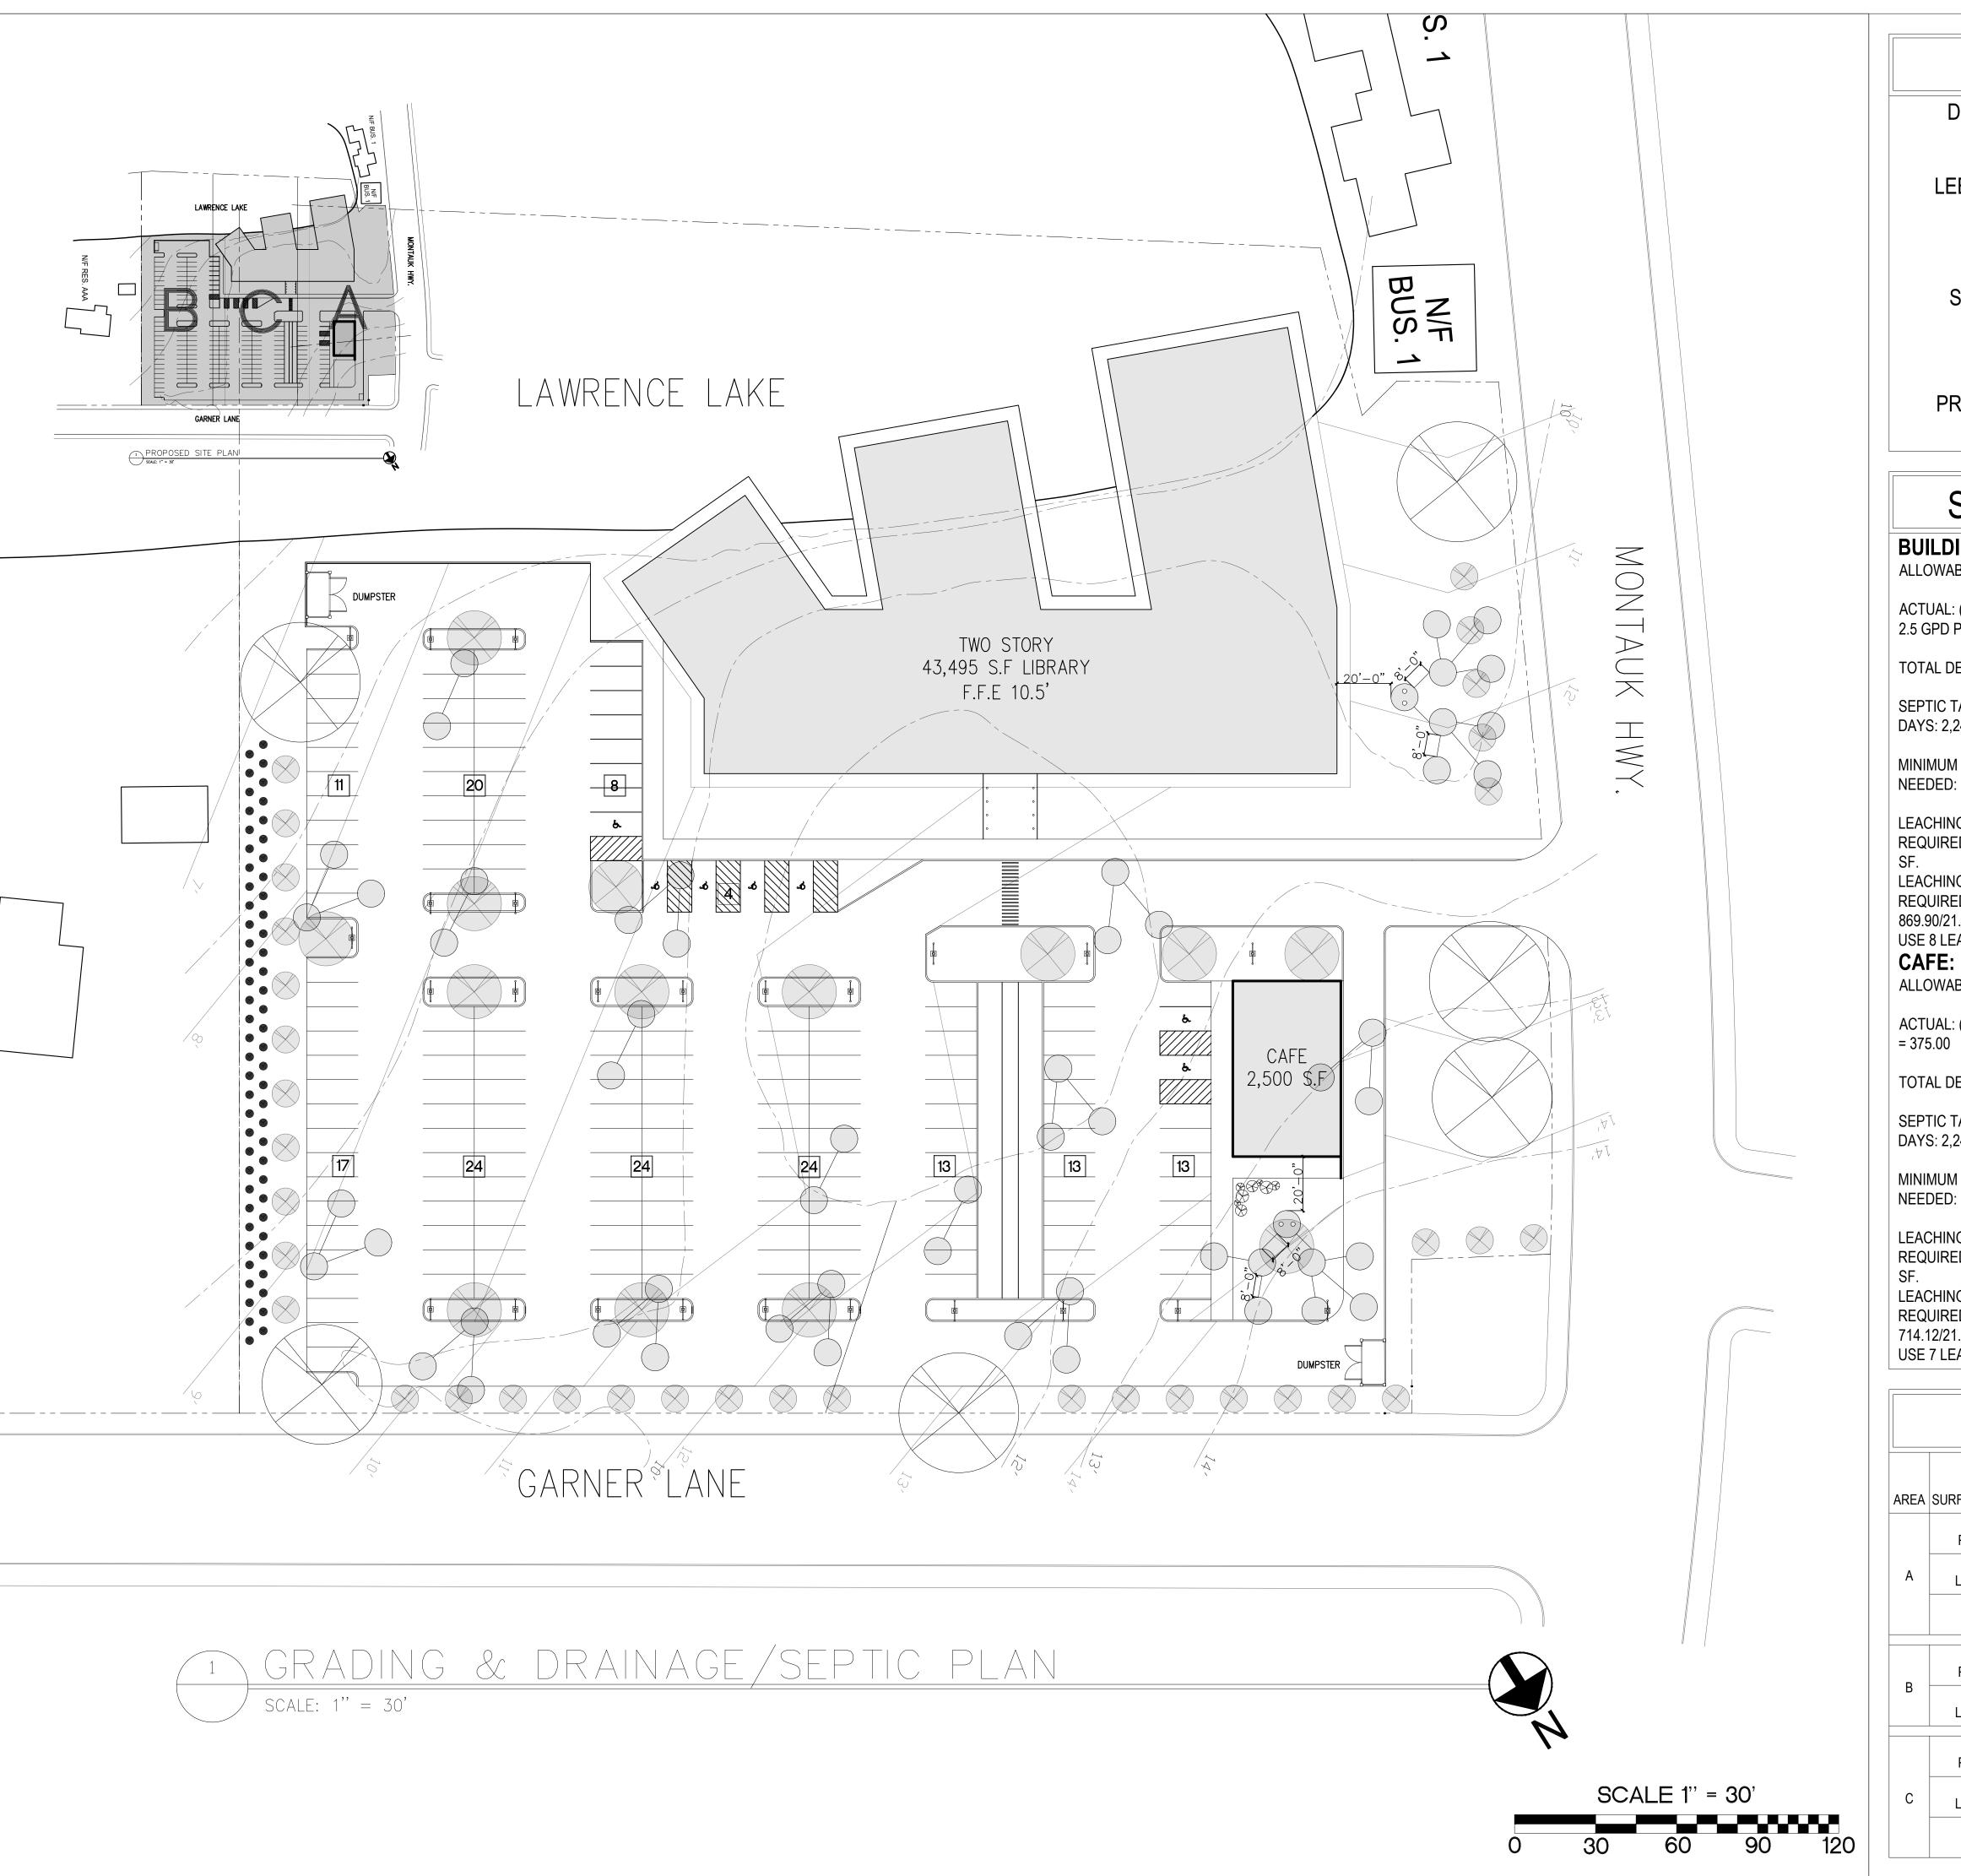
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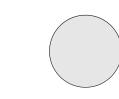


LEGEND


DESCRIPTION

SYMBOL

LEECHING POOL



SEPTIC TANK

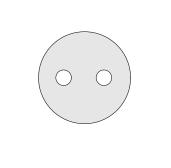

PROPERTY LINE

NOT FOR CONSTRUCTION

SEPTIC REQUIREMENTS

BUILDING:

ALLOWABLE SANITARY FLOW RATE = 2,244

ACTUAL: (GFA) OF THE BUILDING X HYDRAULIC LOAD = 43,495 SF X 0.03 + 2.5 GPD PER OCCUPANT = 1304.85 + 2.5 X 377 = 2,247.35 GPD

TOTAL DENSITY LOAD = 43,495 X 0.03 = 1,305 GPD

SEPTIC TANK: REQUIRED CAPACITY = ACTUAL SANITARY FLOW X 2 DAYS: 2,244 X 2 = 4.5 GAL.

MINIMUM SEPTIC TANK SIZE IN GALLONS OF EFFECTIVE CAPACITY NEEDED: 3,200 GAL. USING 10' DIA. TANK @ 6' LIQUID DEPTH CAPACITY

LEACHING POOLS

REQUIRED SIDE WALL AREA = ACTUAL SANITARY FLOW: 2,244 / 1.5 GPD

LEACHING RATE = 1.496 GPD/SF

REQUIRED DEPTH VF = REQUIRED SIDE WALL AREA / 31.42 SF/ VF = 869.90/21.42 = 22.73 VF

USE 8 LEACHING POOLS @ 6' EFF. DEPTH

ALLOWABLE SANITARY FLOW RATE = 2,244

ACTUAL: (GFA) OF THE BUILDING X HYDRAULIC LOAD = 2,500 SF X 0.15 +

TOTAL DENSITY LOAD = 2,500 X 0.15 = 375.00 GPD

SEPTIC TANK: REQUIRED CAPACITY = ACTUAL SANITARY FLOW X 2 DAYS: 2,244 X 2 = 4.5 GAL.

MINIMUM SEPTIC TANK SIZE IN GALLONS OF EFFECTIVE CAPACITY NEEDED: 3,200 GAL. USING 10' DIA. TANK @ 6' LIQUID DEPTH CAPACITY

LEACHING POOLS

REQUIRED SIDE WALL AREA = ACTUAL SANITARY FLOW: 2,244 / 1.5 GPD

LEACHING RATE = 1.496 GPD/SF

REQUIRED DEPTH VF = REQUIRED SIDE WALL AREA / 31.42 SF/ VF = 714.12/21.42 = 22.73 VF

USE 7 LEACHING POOLS @ 6' EFF. DEPTH

STORMWATER CALC.

-						
AREA	SURFACE MATERIAL	С	I	T. AREA	TOTAL DEPTH OF 10' DIA. LP REQ'D (VF)	
	PAVEMENT	1	0.17	16,594.07		
Α	LANDSCAPE	0.3	0.17	29,472.93	94.70	12
	ROOF	1	0.17	13,202.00		
В	PAVEMENT	1	0.17	34,947.00	98.21	13
	LANDSCAPE	0.3	0.17	17,076.00	33.2	
	PAVEMENT	1	0.17	28,827.00		
С	LANDSCAPE	0.3	0.17	14,379.00	114.92	15
	ROOF	1	0.17	13,747.00		

PROJECT NAME

PROPOSED BAY SHORE LIBRARY

COLLEGE

STATE

INGDALE

1

DESIGN

REVISIONS REV. DATE

DRAWN: CHRISTOPHER VIZCARRA DATE: 08/03/2025 SCALE: 1" = 30' CHECKED: P. LOPICCOLO



CUT & FILL CALCULATIONS				
AREA	CUT (CF)	FILL (CF)		
C1	44.81			
C2	56			
C3	34			
C4	24			
C5	129			
C6	20			
C7	19			
F1		35		
F2		35		
F3		642		
F4		1,647		
F5		246		
F6		23		
F7		46		
TOTAL (CY)	350.81	2,674		
NET C+F 2,323.19				

PROJECT NAME

PROPOSED BAY **SHORE LIBRARY**

NOT FOR CONSTRUCTION

DESIGN ARCH

STATE COLLEGE

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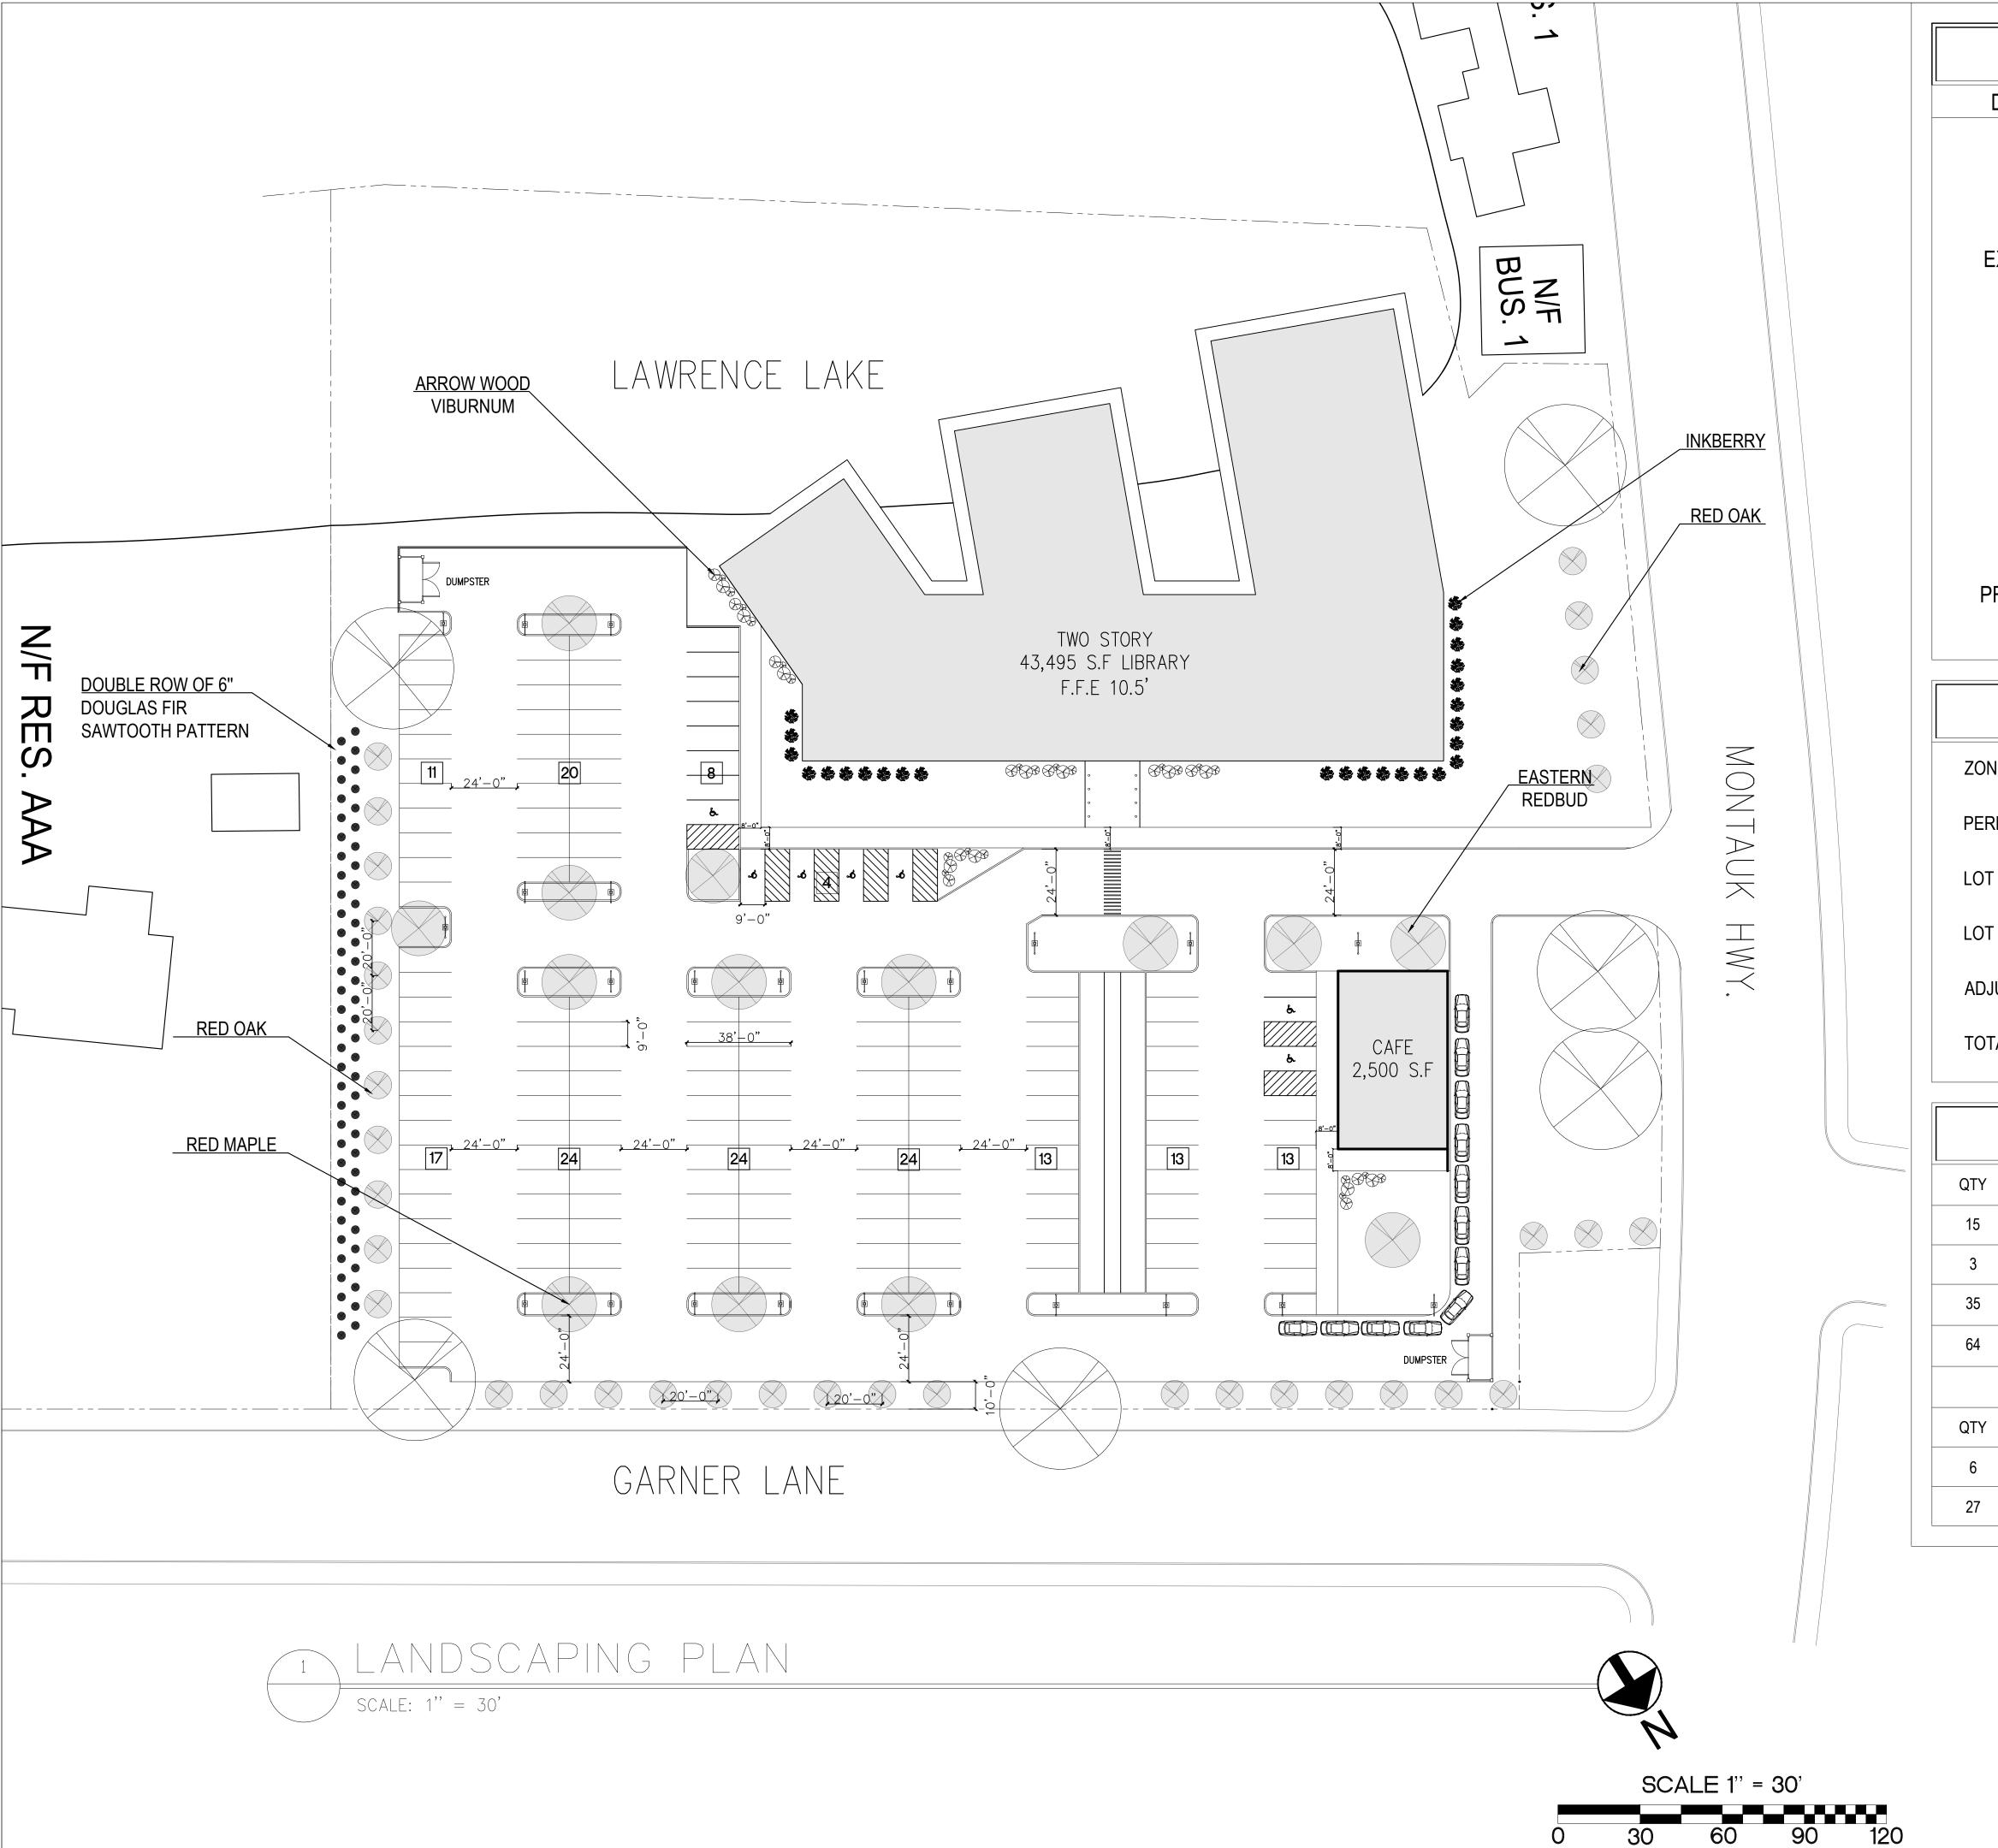
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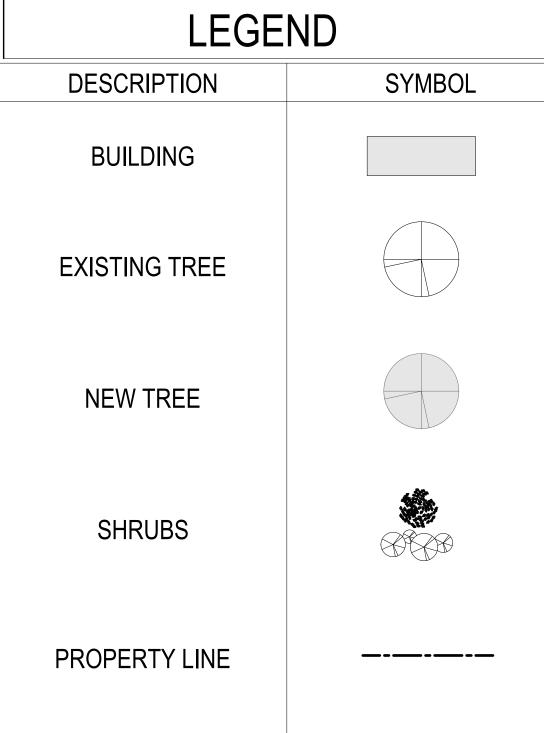
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SCALE:

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SITE INFORMATION

ZONING: BUSINESS DISTRICT 1

PERMITTED USE: LIBRARY

LOT AREA: 4.8 ACRE (209,088 S.F)

LOT AREA UNDER WATER: 1.07 ACRE (46.741 S.F)

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LANDSCAPING PLAN

QTY	EVERGREE	SIZE	
15	ACER RUBRUM	RED MAPLE	2 ½" - 3"
3	CERCIS CANADENSIS	EASTERN REDBUD	$1\frac{1}{2}$ " - $2\frac{1}{2}$ "
35	QUERCUS RUBRA	RED OAK	2" - 6"
64	LIQUIDAMBAR STYRACIFLUA	DOUGLAS FIR	1 ½" - 2 ½"

QTY	SHR	UBS	SIZE
6	SPREA JAPONICA	SPREA	1' - 8'
27	LLEX GLABRA	INKBERRY	3' - 8'

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